

City of Boise  
ADA Assessment

# Hayman House Plans Review

*Prepared by:*



November 6, 2020

To: Ms. Ciera Garechana, ADA/Title VI Coordinator, City of Boise

From: Bryan Weinstein, P.E., AI/PE, Director of ADA Compliance and Accessibility Services, Tindale Oliver

Subject: ADA Compliance Review of Erma Hayman House Restoration Design Plans

This memorandum has been prepared in response to the City of Boise Idaho's request for Tindale Oliver to perform a review of the subject design criteria and drawings for adherence with the requirements of the Americans with Disabilities Act Accessibility Guidelines (ADAAG). This task includes a comprehensive review of the Architectural, Structural, and Landscape design plans prepared by Trout Architects and others dated July 30, 2020.

This review was performed in consideration of the applicable requirements of the ADAAG as revised and published by the U.S. Access Board on July 26, 2004, and adopted as regulatory requirements by the U.S. Department of Justice on September 15, 2010, as the 2010 ADA Standards.

Please note that this review represents our professional opinion, given our extensive experience with ADA regulatory requirements for Titles II and III entities. Although our review does not constitute a certification of compliance with the ADA as no formal authoritative certification process is obtainable, the review was performed by an ICC (International Code Council) certified Accessibility Inspector and Plans Examiner.

### **Evaluation**

This design review follows an extensive review process and reports any deficiencies or omissions included in the project design drawings. This design level review reflects consideration of the compliance with the ADA requirements as depicted or described in the design elements of this project. Where omissions of requirements are known, every attempt has been made to identify those omissions.

The following table provides comments resulting from the design plans review where conflicts or omissions of ADA requirements are found and includes the ADA requirements described above.

Drawing/ Sheet No.	Erma Hayman House Restoration Design Review	ADAAG Requirements
General	<p>The designers of this project have considered the accessibility requirements and have included key elements meeting ADA standards. Our comments to follow are mostly reminders or remarks specific to elements where the ADA requirements are not clearly specified</p> <p>Parking is not identified in the design package. Should public parking be provided at this facility, consideration to all ADA requirements for parking and connected accessible routes must be considered.</p>	N/A
A0.0 Cover	<p>CODE DATA:</p> <p>Suggest adding "USDOJ 2010 ADA Standards for Accessible Design (9.15.2010)"</p>	28 CFR §35.151. Construction and/or alteration of existing facilities are governed by the accessibility regulations enforced by the U.S. Department of Justice
A0.0 Cover	<p>GENERAL BUILDING CODE NOTES:</p> <p>The notes state, "This building is considered eligible for listing in the National Register of Historic Places." The ADA requires full compliance with the accessibility requirements for any elements altered during the project unless it is not feasible due to structural or threat to the historic significance of the facility.</p>	<p>§36.405 Alterations: Historic preservation.</p> <p>(a) Alterations to buildings or facilities that are eligible for listing in the National Register of Historic Places under the National Historic Preservation Act (16 U.S.C. 470 et seq.) or are designated as historic under State or local law, shall comply to the maximum extent feasible with this part.</p> <p>(b) If it is determined that it is not feasible to provide physical access to an historic property that is a place of public accommodation in a manner that will not threaten or destroy the historic significance of the building or the facility, alternative methods of access shall be provided pursuant to the requirements of subpart C of this part.</p>

Drawing/ Sheet No.	Erma Hayman House Restoration Design Review	ADAAG Requirements
A1.2 First Level	Detail 3: A text box is provided with a description of the inaccessibility of the porch entrance to the building and the alternative accessible entrance to the provided at the new west door. While we concur with this determination and constructing the new west accessible entrance will satisfy the ADA requirements for at least one accessible entrance, caution is advised as it appears as though a ramp could be constructed on the surface that could provide access to the porch. Should this section of the facility be altered, it could be a challenge to justify not installing an accessible means of access to the "main" entrance.	State and local government facilities must follow the requirements of the 2010 Standards, including both the Title II regulations at 28 CFR 35.151; and the 2004 ADAAG at 36 CFR part 1191, appendices B and D.
A1.2 First Level	Detail 3: The assembly area indicates a total of 40 chairs provided. It is not clear if these chairs are stationary or portable. ADAAG requires a minimum of two wheelchair spaces be provided for a 40-chair space. This detail indicates space for only one wheelchair.	221.2.1.1 provides a table indicating a minimum of two wheelchair spaces must be provided when the total number of fixed seating provided is between 26 and 50.
A2.1 Exterior Elevations	Detail 9, East Ramp Section: It is unclear as to the designed slope and horizontal length of this section of ramp. The ADA requires that for each 30' of horizontal projection of a ramp greater than 5% in slope, a landing must be provided.	405.6 Rise. The rise for any <i>ramp</i> run shall be 30 inches (760 mm) maximum.  405.7 Landings. <i>Ramps</i> shall have landings at the top and the bottom of each <i>ramp</i> run. Landings shall comply with 405.7.


Drawing/ Sheet No.	Erma Hayman House Restoration Design Review	ADAAG Requirements
A2.2  Interior Elevations	<p>Details 14, 10 and 6, Entry Elevations: Required tactile (raised character and Braille signage is shown in details 14 and 10 indicating a mounting height of 60" maximum. The required reach range for these signs are specific for a minimum of 48" and maximum of 60" above the finished floor to the bottom of the highest line of raised characters.</p> <p>At detail 6, an exit sign is shown mounted over the door. The ADA requires that a tactile sign be installed at all designated exit doorways of a building.</p>	<p>703.4.1 Height Above Finish Floor or Ground. <i>Tactile characters</i> on signs shall be located 48 inches (1220 mm) minimum above the finish floor or ground surface, measured from the baseline of the lowest <i>tactile character</i> and 60 inches (1525 mm) maximum above the finish floor or ground surface, measured from the baseline of the highest <i>tactile character</i>.</p> <p>216.4.1 Exit Doors. Doors at exit passageways, exit discharge, and exit stairways shall be identified by <i>tactile signs</i> complying with 703.1, 703.2, and 703.5.</p>

### Summary of Findings

The focus of this review was to ascertain whether the design plans of the Hayman House Improvements project meet the requirements of ADAAG. If recommendations are adopted as provided in the findings given in the above table, and through additional reviews as the design advances, the design for the Hayman House Improvements will provide compliance in meeting the minimum requirements of the Americans with Disabilities Act accessibility standards.

If you have questions, please feel free to contact me at (443) 438-5392 ext. 1242 or via e-mail: [bweinstein@tindaleoliver.com](mailto:bweinstein@tindaleoliver.com).



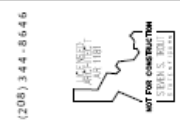

**MOT FOR CONSTRUCTION**  
 STRONG BUILD  
 SUSTAINABLE

**City of Boise Arts & History  
 Erma Hayman House Restoration**  
 617 South Ash Street, Boise, Idaho 83702


DATE	2018.03.09
PROJECT NO.	2018.03.09
DATE	7/26/20
SHEET TITLE	SITE PLAN
SHEET NO.	A1.0

**KEYNOTE LEGEND**

NUMBER	TEXT
00.00	CONCRETE IN EXISTING WITH REINFORCING EXPOSED
01.17	REMOVE EXISTING TO REMAIN - PROTECT
01.20	REMOVE EXISTING TO REMAIN - PROTECT
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02.00	REMOVE EXISTING TO REMAIN - PROTECT

**SITE WORK GENERAL NOTES:**

- EXACT CONDITIONS MAY VARY PLUS THE CONTRACTOR'S RESPONSIBILITY TO VERIFY THE CONDITIONS. THE CONTRACTOR IS TO ACCURATELY COORDINATE EXISTING WORK WITH NEW WORK. THE CONTRACTOR SHALL BE RESPONSIBLE FOR OBTAINING ALL NECESSARY PERMITS AND NOTIFICATIONS REQUIRED TO ACCOMMODATE ALL NEW WORK REQUIRED TO COMPLETE THE PROJECT AT THE ADDITIONAL COST TO THE OWNER.
- LANDSCAPING MATERIALS THROUGHOUT CONSTRUCTION.
- CONTRACTOR TO CALL FOR BIDDING PRIOR TO ANY EXCAVATION WORK.
- EXISTING UTILITIES TO BE MAINTAINED SHALL BE PROTECTED AS REQUIRED.
- ALL EXCAVATION SHALL BE PROTECTED AS REQUIRED.
- SAVAILABLE ITEMS REMOVED UNDER EXCAVATION WORK. COORDINATE WITH AGENCY CONTRACTOR TO TAKE CARE TO PROTECT EXISTING HISTORIC DETAILS AND FINISHES.
- CONTRACTOR TO TAKE CARE TO PROTECT EXISTING HISTORIC DETAILS AND FINISHES. PROTECT ALL EXISTING HISTORIC DETAILS AND FINISHES. CLEAN WORKING SURFACE AND MAINTAIN HISTORIC CHARACTERISTICS DUE TO NEW WORK.

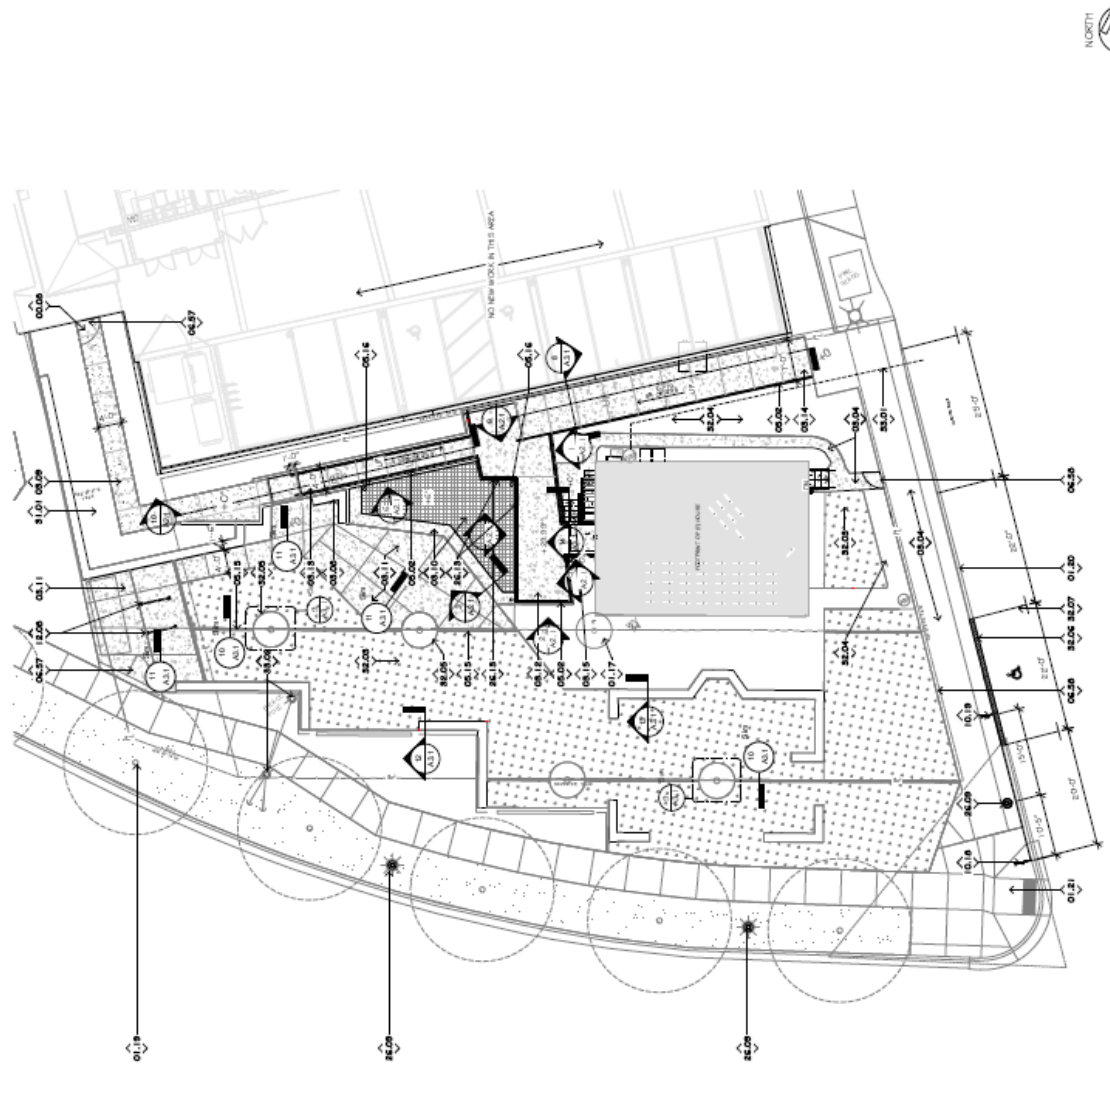

1 SITE PLAN - NEW WORK  
 1" = 10'-0"







DATE	7/20/20
PROJECT NO.	2016.030
REVISION	
DESIGNED BY	
CHECKED BY	
PROJECT NO.	2016.030
DATE	7/20/20
SHEET TITLE	CONCRETE LAYOUT PLAN
SHEET NO.	A1.1

**SEE WORK GENERAL NOTES**


- A. EXISTING CONDITIONS MAY VARY. IT IS THE CONTRACTOR'S RESPONSIBILITY TO VISIT THE SITE PRIOR TO BEGINNING THE ACTUAL AMOUNT OF SITE WORK REQUIRED. THE CONTRACTOR SHALL BE RESPONSIBLE FOR VERIFYING THE EXISTING CONDITIONS AND MARK PRIOR TO BEGINNING. THE CONTRACTOR IS RESPONSIBLE TO PROVIDE ALL NECESSARY PERMITS AND APPROVALS FOR ALL WORK REQUIRED TO COMPLETE THE PROJECT AND TO OBTAIN ALL NECESSARY PERMITS AND APPROVALS.
- B. CONTRACTOR TO PROTECT, MAINTAIN AND RESTORE ALL EXISTING UTILITIES, IRRIGATION SYSTEMS, AND OTHER FEATURES AND CONDITIONS TO REMAIN. THE CONTRACTOR SHALL BE RESPONSIBLE TO OBTAIN ALL NECESSARY PERMITS AND APPROVALS FOR ALL WORK REQUIRED TO COMPLETE THE PROJECT AND TO OBTAIN ALL NECESSARY PERMITS AND APPROVALS.
- C. CONTRACTOR TO CALL FOR LOCATE PRIOR TO ANY EXCAVATION WORK. THE CONTRACTOR SHALL BE RESPONSIBLE FOR OBTAINING ALL NECESSARY PERMITS AND APPROVALS FOR ALL WORK REQUIRED TO COMPLETE THE PROJECT AND TO OBTAIN ALL NECESSARY PERMITS AND APPROVALS.
- D. CONTRACTOR TO CALL FOR LOCATE PRIOR TO ANY EXCAVATION WORK. THE CONTRACTOR SHALL BE RESPONSIBLE FOR OBTAINING ALL NECESSARY PERMITS AND APPROVALS FOR ALL WORK REQUIRED TO COMPLETE THE PROJECT AND TO OBTAIN ALL NECESSARY PERMITS AND APPROVALS.
- E. CONTRACTOR TO CALL FOR LOCATE PRIOR TO ANY EXCAVATION WORK. THE CONTRACTOR SHALL BE RESPONSIBLE FOR OBTAINING ALL NECESSARY PERMITS AND APPROVALS FOR ALL WORK REQUIRED TO COMPLETE THE PROJECT AND TO OBTAIN ALL NECESSARY PERMITS AND APPROVALS.
- F. CONTRACTOR TO CALL FOR LOCATE PRIOR TO ANY EXCAVATION WORK. THE CONTRACTOR SHALL BE RESPONSIBLE FOR OBTAINING ALL NECESSARY PERMITS AND APPROVALS FOR ALL WORK REQUIRED TO COMPLETE THE PROJECT AND TO OBTAIN ALL NECESSARY PERMITS AND APPROVALS.

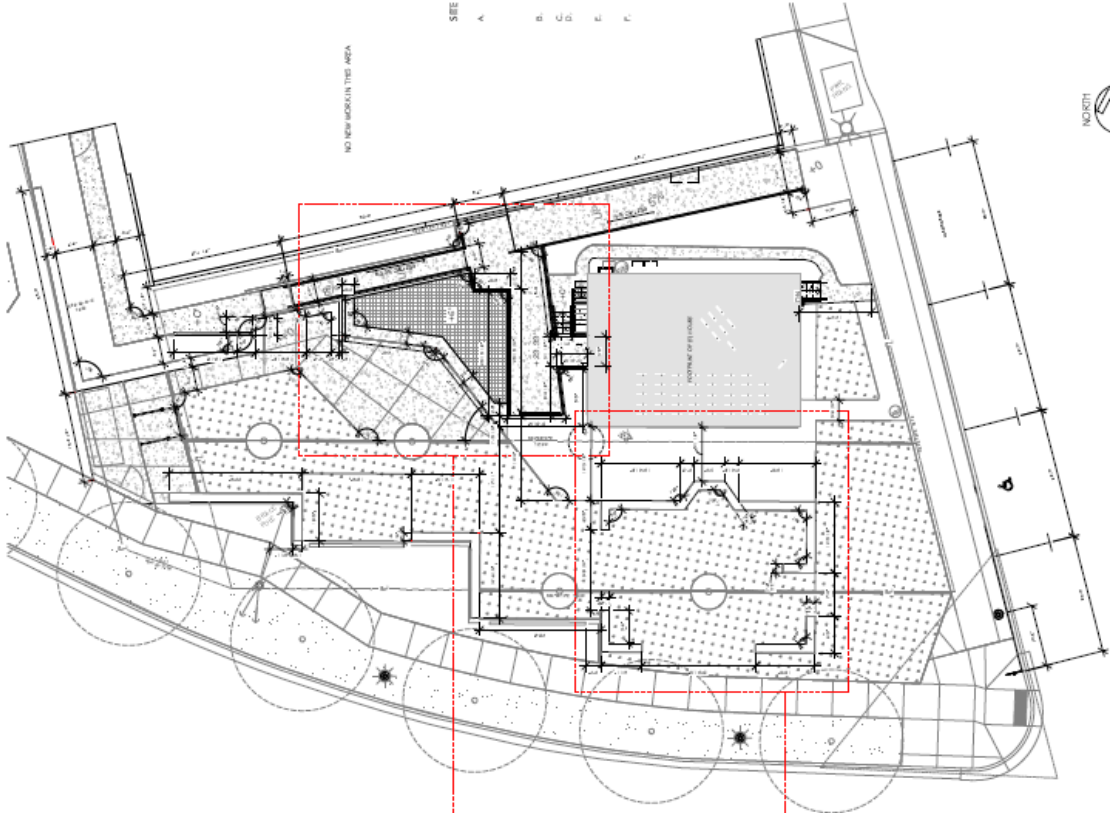

NO NEW WORK IN THIS AREA

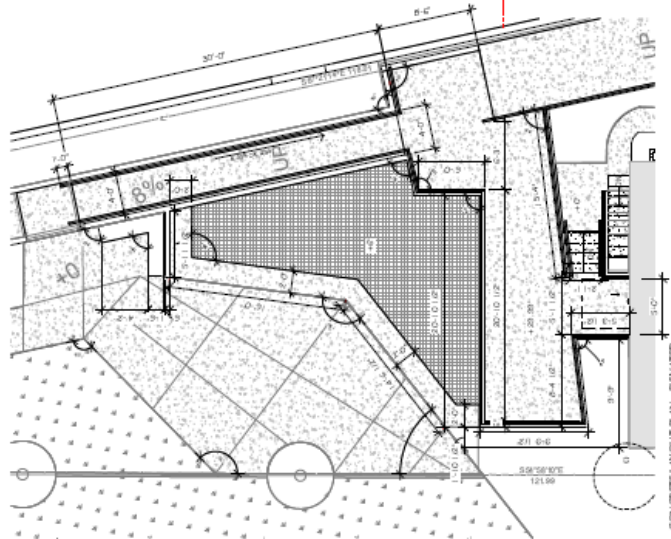

1 CONCRETE LAYOUT PLAN - STAGE AREA  
3/16" = 1'-0"

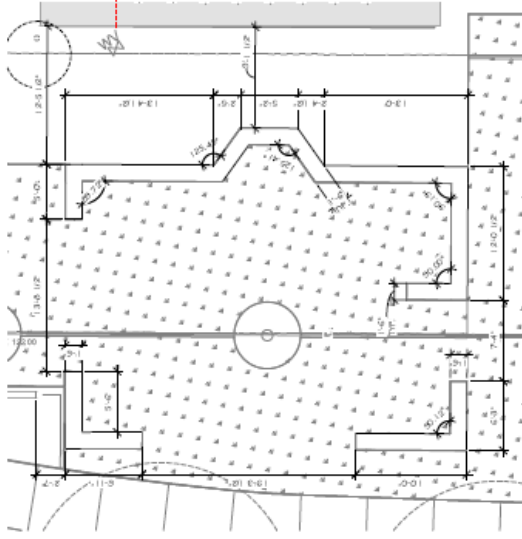


2 CONCRETE LAYOUT PLAN - FOUNDATION WALLS  
3/16" = 1'-0"

1 CONCRETE LAYOUT PLAN  
1/4" = 10'-0"





KEYNOTE LEGEND	
NUMBER	NOTE
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**ELECTRICAL LEGEND**

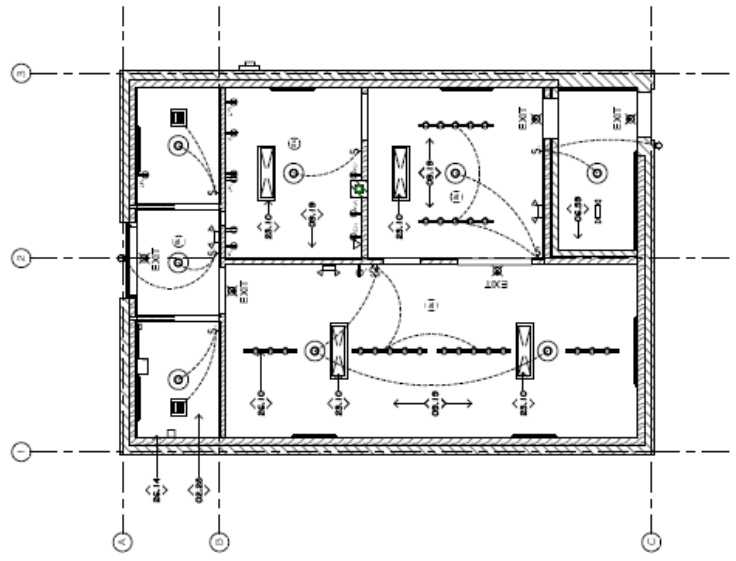- FLUSH MOUNT LIGHT FIXTURE
- TRACK LIGHT FIXTURE
- SINGLE ELECTRICAL SWITCH
- DOUBLE ELECTRICAL SWITCH
- DIMMABLE ELECTRICAL SWITCH
- DATA PORT RECEPTACLE
- STANDARD DUPLEX RECEPTACLE
- 4PO DUPLEX RECEPTACLE
- 200V ELECTRICAL RECEPTACLE
- SMOKE & OXIDIZER DETECTOR
- 200V PANEL BOARD, 200V EQUIP. RECEPTION EXHAUST FAN
- LIGHTED EXIT SIGN WITH BATTERY BACKUP POWER
- EMERGENCY LIGHTING WITH BATTERY BACKUP POWER
- CEILING MOUNT MECHANICAL CASSETTE
- EMERGENCY OUTDOOR LIGHT

1 FIRST FLOOR - NEW CEILING PLAN  
1/8" = 1'-0"

**TROUT ARCHITECTS CHARTERED**  
2504 W. KOOTENAI BOISE, ID 83705  
(208) 344-8646



**City of Boise Arts & History**  
**Erma Hayman House Restoration**  
617 South Ash Street, Boise, Idaho 83702

**NOT FOR CONSTRUCTION**  
STAFF'S REVIEW  
DATE: 7/20/20  
PROJECT NO: 2019.030  
SHEET TITLE: FIRST FLOOR CEILING PLAN  
SHEET NO: A1.3









REYNOLDS LEGEND


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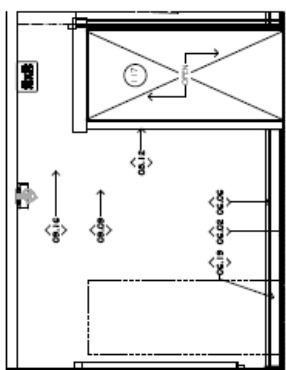
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 1/2" = 1'-0"

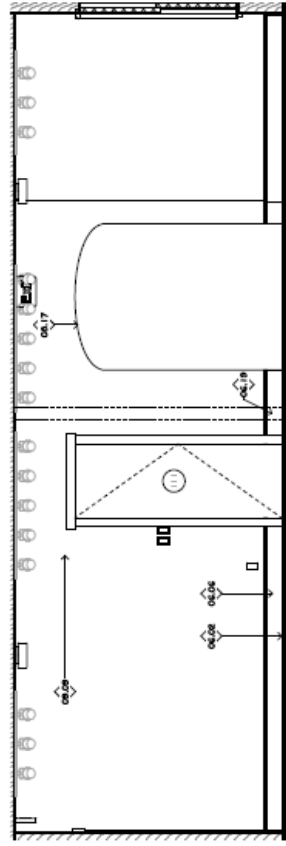


5 East Room Elevation - SOUTH  
 1/2" = 1'-0"

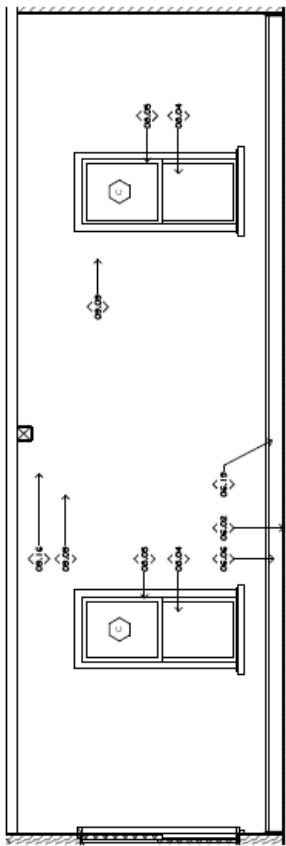


6 East Room Elevation - EAST  
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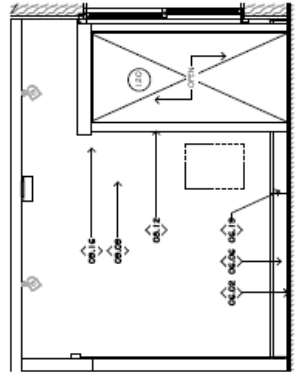
8 East Room Elevation - WEST  
 1/2" = 1'-0"

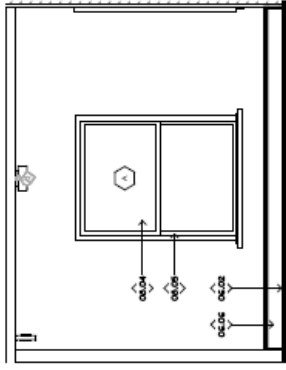


3 East Room Elevation - NORTH  
 1/2" = 1'-0"

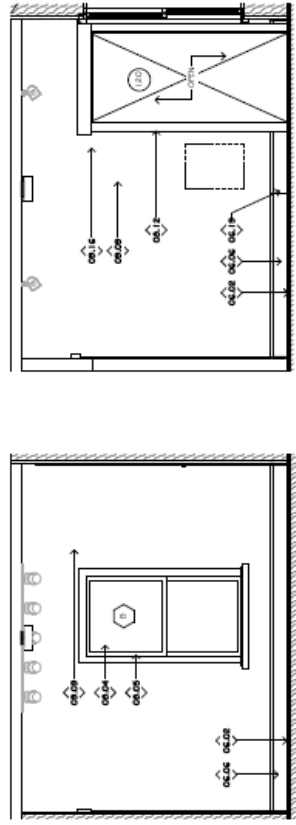

2 East Room Elevation - SOUTH  
 1/2" = 1'-0"

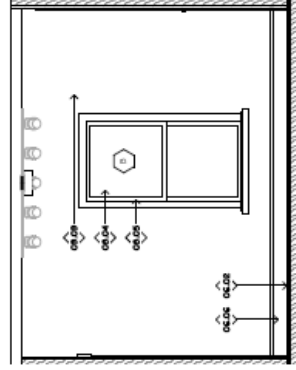

4 East Room Elevation - WEST  
 1/2" = 1'-0"

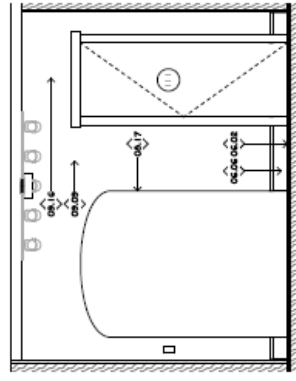

1 East Room Elevation - SOUTH  
 1/2" = 1'-0"






















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DATE	7/26/20
PROJECT NO.	2018.030
PROJECT NAME	ERMA HAYMAN HOUSE RESTORATION
ARCHITECT	TROUT ARCHITECTS
SCALE	AS SHOWN
DATE	7/26/20
SHEET TITLE	WALL SECTIONS & DETAILS
SHEET NO.	A3.1

NUMBER	TEXT
21.0	REINFORCE FLOOR JOISTS TO REMAIN. MIN. 10% PROTECT.
21.1	REMOVE EXISTING INTERIOR PARTITION WALLS. REPAIR EXISTING INTERIOR PARTITION WALLS TO REMAIN. MIN. 10% PROTECT.
21.2	REMOVE EXISTING INTERIOR PARTITION WALLS. REPAIR EXISTING INTERIOR PARTITION WALLS TO REMAIN. MIN. 10% PROTECT.
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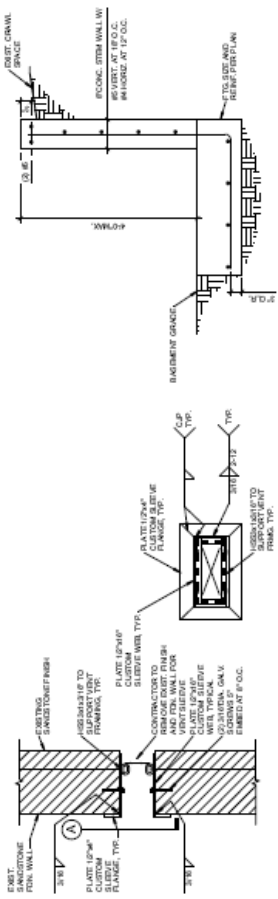




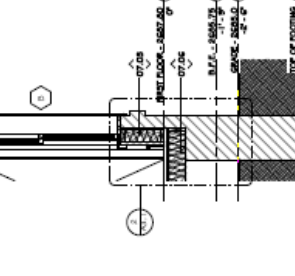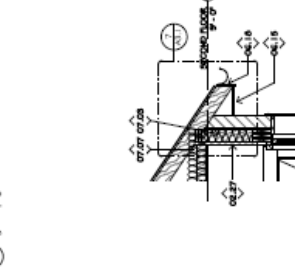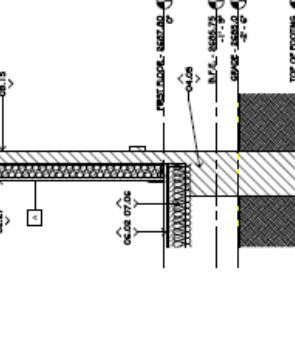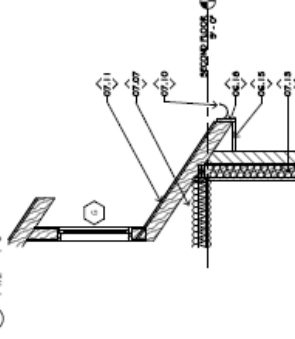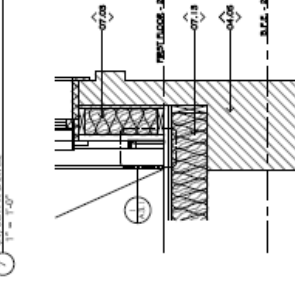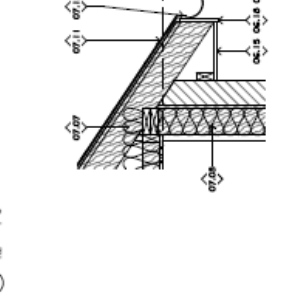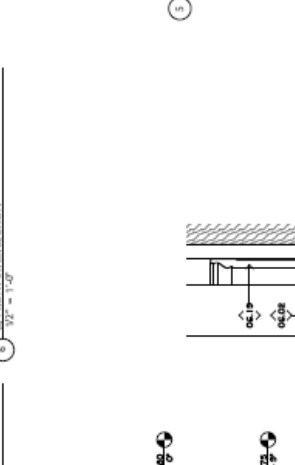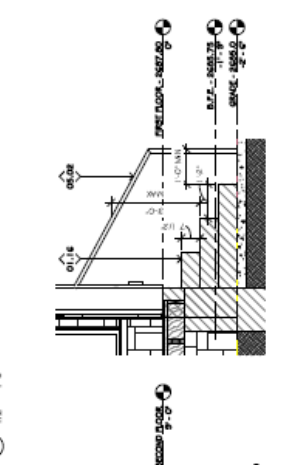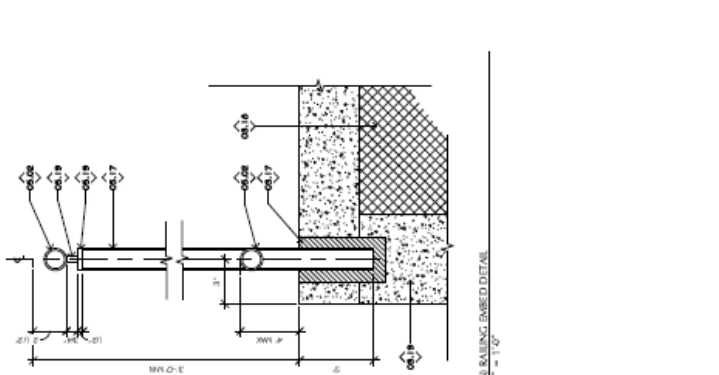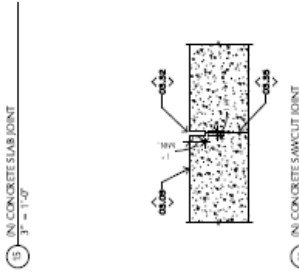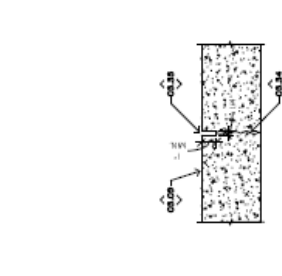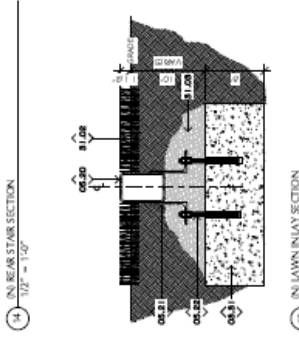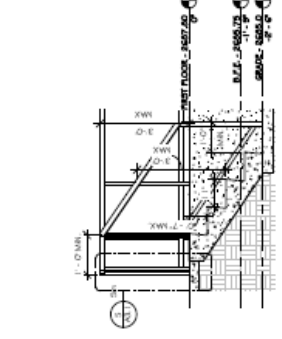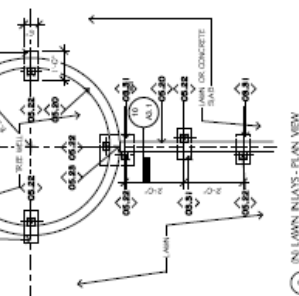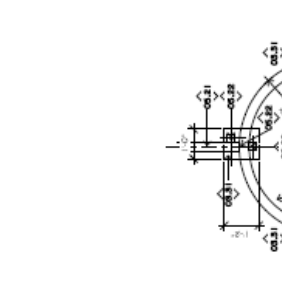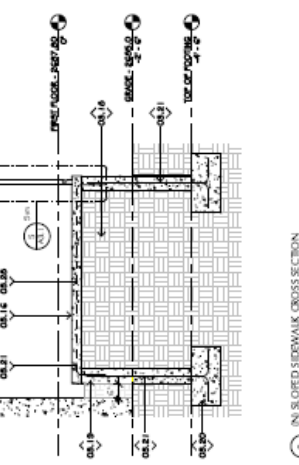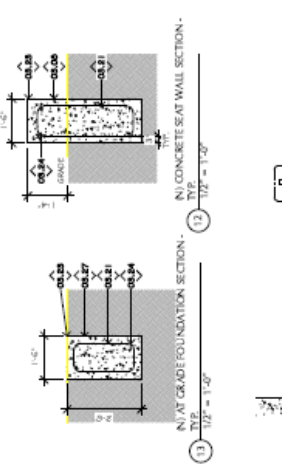





DATE: 07/23/2020	PROJECT NO: 2019-030
ISSUE NO: 07/23/2020	PROJECT TITLE: ERMA HAYMAN HOUSE RESTORATION
SHEET NO: S2.1	



1 VENT SLEEVE DETAIL  
 3/8" = 1'-0"

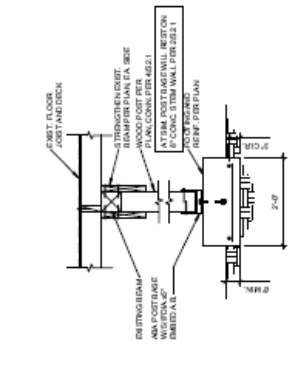


2 BASEMENT RETAINING WALL  
 3/8" = 1'-0"

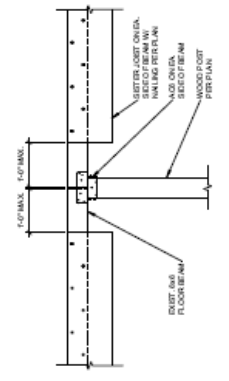


3 INTERIOR PONY WALL  
 3/8" = 1'-0"


4 WOOD POST TO BEAM CONNECTION  
 3/8" = 1'-0"

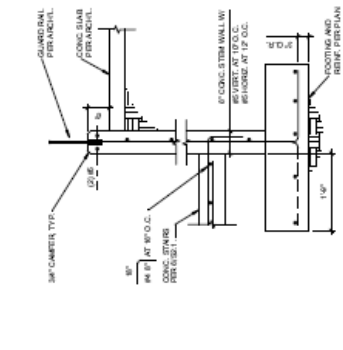

5 WALL SECTION AT STAIRS  
 3/8" = 1'-0"

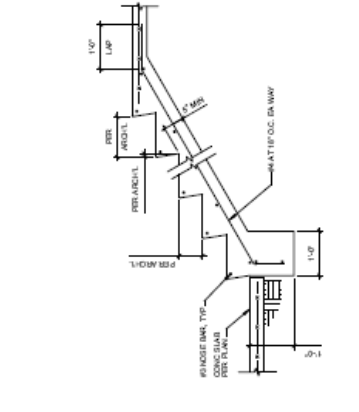

6 CONCRETE STAIRS ON GRADE  
 3/8" = 1'-0"

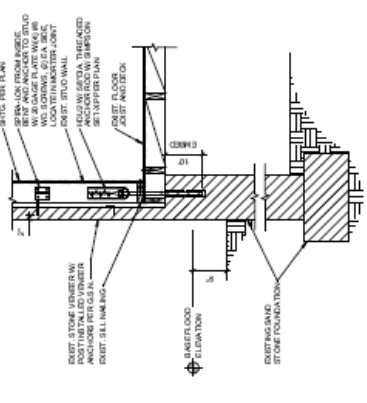

7 EXTERIOR WALL  
 3/8" = 1'-0"

4 WOOD POST TO BEAM CONNECTION  
 3/8" = 1'-0"



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